
PLUMBING FIXTURE SCHEDULE DESCRIPTION MOUNTING TYPE MANUFACTURER MODEL NUMBER | WASTE | VENT | COLD | HOT ACCESSORIES JR SMITH (OR EQUAL) 3411 (OR EQUAL) FLOOR SINK FLOOR 8 INCHES SQUARE WITH TRAP PRIMER CONNECTION AND SEDIMENT BUCKET - PROVIDE 6" FUNNEL KOHLER (OR EQUAL) K-2005 (OR EQUAL) LOCKER ROOM FIXTURES WITH MOEN #8307 FAUCET & LAMINAR FLOW AERATOR - PROVIDE ARM STYLE CARRIER LAVATORY KOHLER (OR EQUAL) K-2005 (OR EQUAL) 2" 1-1/2" ½" ½" WITH MOEN #CA8303 GOOSENECK BATTERY OPERATED ELECTRONIC FAUCET WITH SEPARATE MOEN #104424 MIXING VALVE SINK EXAM ROOM SINK KOHLER (OR EQUAL) K-4325 (OR EQUAL) WITH WHITE HEAVY DUTY SEAT (WITH CHECK HINGES) AND MOEN #8310 FLUSH VALVE AND JR SMITH CARRIER WATER CLOSET LOCKER ROOM FIXTURES

PIPE SCHEDULE				
SYSTEM	PIPE MATERIAL	SIZE	INSULATION THICKNESS	REMARKS
DOMESTIC COLD WATER	'L' COPPER	ALL	1/2"	PRO-FIT/SOLDERED
DOMESTIC HOT WATER	'L' COPPER	ALL	1"	PRO-FIT/SOLDERED
WASTE	CAST IRON	ALL	NONE	ABOVE GRADE
VENT	CAST IRON	ALL	NONE	ABOVE GRADE
MED AIR/MED VAC/MED O2	'L' COPPER	ALL	NONE	BRAZED JOINTS
MED VACUUM	'L' COPPER	ALL	NONE	BRAZED JOINTS

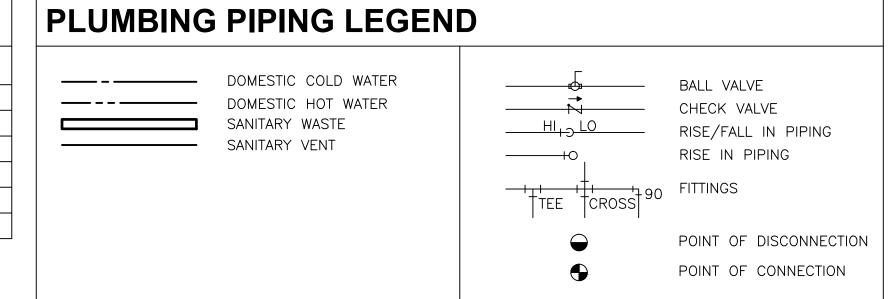

GENERAL NOTES:

A. IT IS ABSOLUTELY NECESSARY FOR ALL TRADES INVOLVED TO COORDINATE WITH EACH OTHER AND VERIFY THAT THERE ARE NO CONFLICTS IN LOCATION OF PIPING DUCTS, CONDUITS, DIFFUSERS, BOXES AND OTHER ITEMS THROUGHOUT THIS PROJECT BEFORE FINAL PLACEMENT OF MATERIALS.

ALL DIMENSIONS AND EXACT UNIT AND PIPING LOCATIONS ARE TO BE FIELD VERIFIED. THESE DRAWINGS REPRESENT SCHEMATIC SYSTEMS BASED ON INFORMATION PROVIDED BY OTHERS.

PROVIDE SEISMIC BRACING OF ALL EQUIPMENT AND PIPING AS REQUIRED BY LOCAL CODES.

O. COORDINATE AVAILABLE SPACE FOR EQUIPMENT AND PIPING SYSTEMS WITH OTHER TRADES. REFER TO ARCHITECTURAL, STRUCTURAL, PLUMBING, AND ELECTRICAL DRAWINGS AND FIRE PROTECTION SHOP DRAWINGS FOR ADDITIONAL DETAILS NECESSARY FOR COORDINATION.

E. ALL PIPING IS SCHEMATICALLY DRAWN AND COORDINATION BETWEEN TRADES MUST BE DONE FOR PROPER EQUIPMENT, PIPING, AND DUCTWORK PLACEMENT AND DESIGN.

CONTRACTOR IS TO ROUTE ALL PIPING TO AVOID STRUCTURAL MEMBERS AS FIELD CONDITIONS DICTATE. IF PIPING IS SHOWN AS GOING THROUGH A STRUCTURAL MEMBER, THIS WILL NEED TO BE ADJUSTED IN THE FIELD TO FIT OR THE MEMBER WILL NEED TO BE PENETRATED. PIPING LOCATIONS ARE SHOWN AS APPROXIMATE AND NOT EXACT. CONTRACTOR IS TO CHECK PIPING DIMENSIONS IN THE FIELD.

G. FOLLOW MANUFACTURES WRITTEN INSTALLATION INSTRUCTION FOR RUNNING THE COMBUSTION AIR AND VENT PIPING AS WELL AS THE TERMINATION THROUGH THE ROOF. FOLLOW ALL SAFETY INSTRUCTIONS.

COORDINATE ALL CONCRETE PENETRATIONS WITH STRUCTURAL DRAWINGS TO VERIFY HOW AND WHERE CONCRETE CAN BE CUT.

ALL PIPING THAT IS EXPOSED MUST BE PAINTED TO MATCH SURROUNDINGS.

J. MECHANICAL CONTRACTOR SHALL FIRE SEAL ALL PIPING PASSING THROUGH RATED CONSTRUCTION.

Construction Document Submission 18 July 2014


VA FORM 08-6231

ASEE ARCHITECTS&
ARCHITECTURE
INTERIORS
HISTORIC

608 NORTH 29TH
BILLINGS, MT 59101
PH 406.248.2633
FAX 406.248.2427

224 N. HIGGINS, SUITE B
MISSOULA, MT 59802
PH 406.721.5643
FAX 406.721.1887

www.aearchitects.com

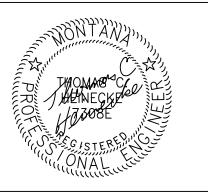



Drawing Title
PLUMBING SCHEDULES

Approved: Project Director

AARON DRIVDAHL, PROJECT ENGINEER
VAMC FORT HARRISON

Project Title

VAMC FORT HARRISON

SPD RENOVATION

Location

FT. HARRISON, MONTANA

Checked

JTW

TCH

Project Number
436-14-109

Building Number
154


Drawing Number

PL601

Dwg. 27 of 39


Office of Construction and Facilities Management

Department of Veterans Affairs

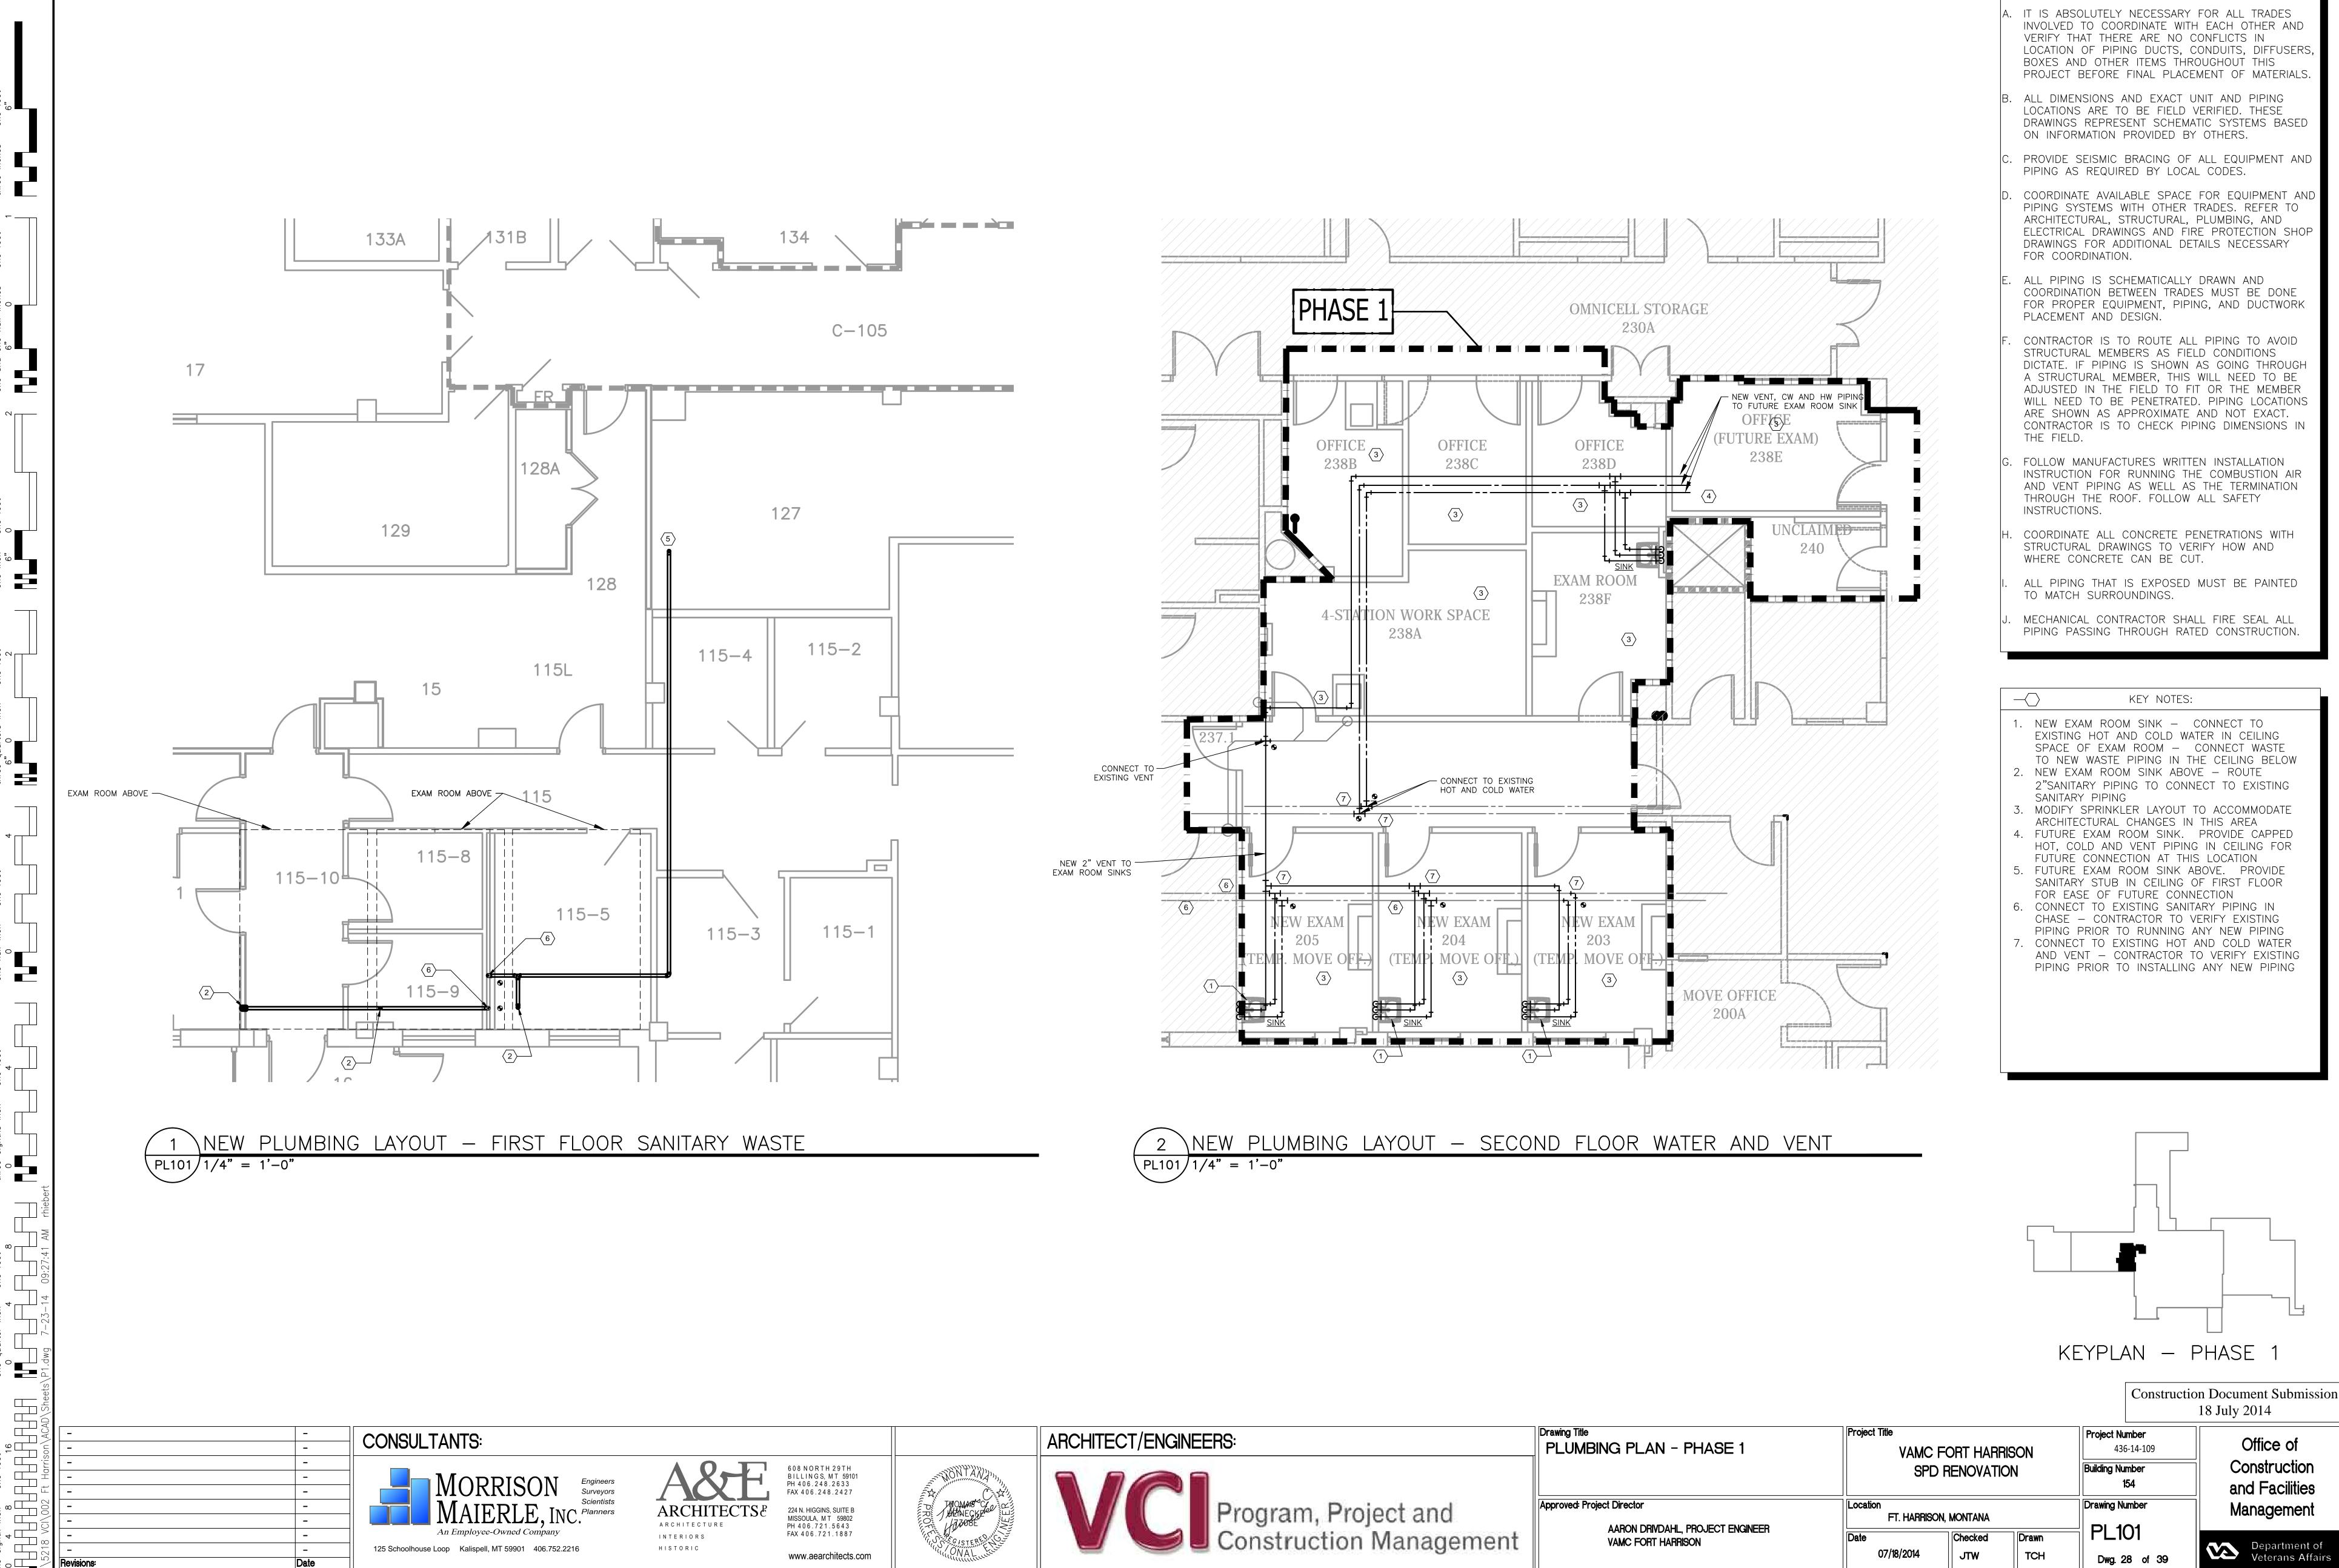

VA FORM 08-623

GENERAL NOTES:

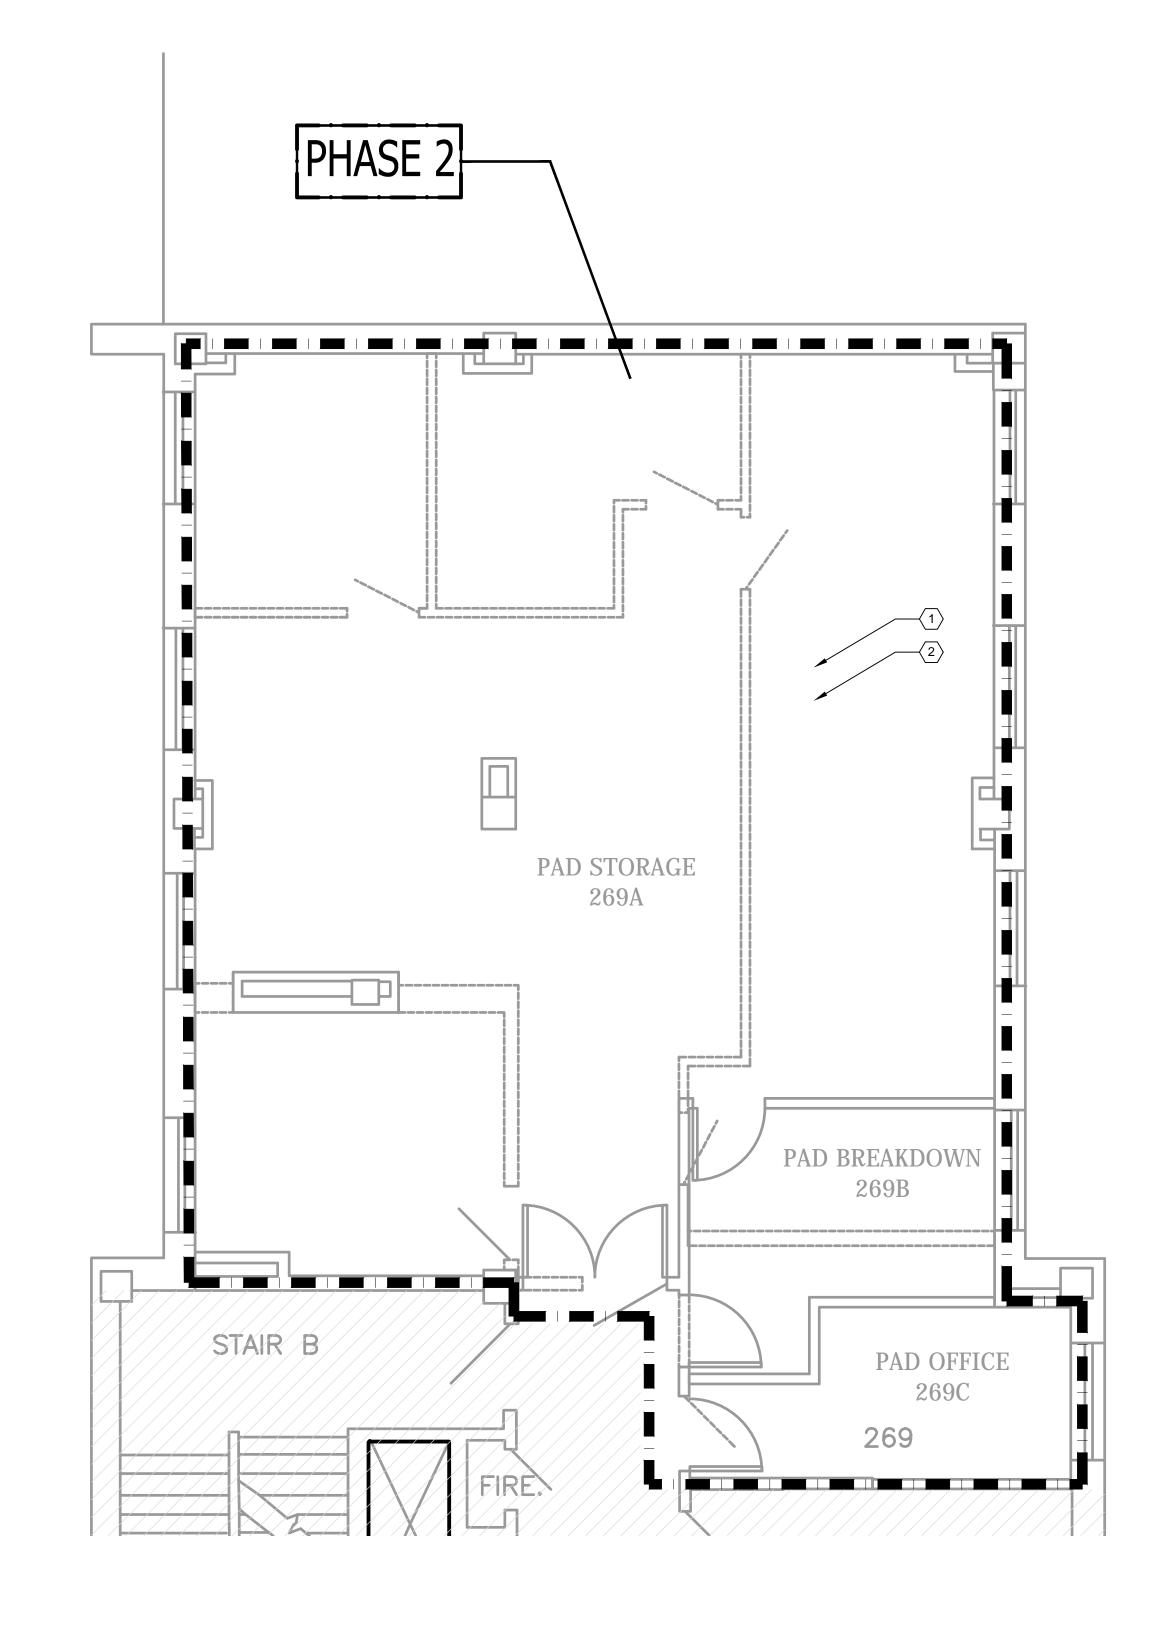

1 \PLUMBING LAYOUT $\sqrt{PL102/1/4"} = 1'-0"$

608 NORTH 29TH BILLINGS, MT 59101 PH 406.248.2633

224 N. HIGGINS, SUITE B MISSOULA, M T 59802 PH 4 0 6 . 7 2 1 . 5 6 4 3

FAX 406.721.1887

INTERIORS

HISTORIC

CONSULTANTS:

| -

| -

-

MORRISON
Surveyors
Scientists
NAIERLE, INC.
Planners

An Employee-Owned Company

125 Schoolhouse Loop Kalispell, MT 59901 406.752.2216


VA FORM 08-6231

GENERAL NOTES:

- IT IS ABSOLUTELY NECESSARY FOR ALL TRADES INVOLVED TO COORDINATE WITH EACH OTHER AND VERIFY THAT THERE ARE NO CONFLICTS IN LOCATION OF PIPING DUCTS, CONDUITS, DIFFUSERS, BOXES AND OTHER ITEMS THROUGHOUT THIS PROJECT BEFORE FINAL PLACEMENT OF MATERIALS.
- ALL DIMENSIONS AND EXACT UNIT AND PIPING LOCATIONS ARE TO BE FIELD VERIFIED. THESE DRAWINGS REPRESENT SCHEMATIC SYSTEMS BASED ON INFORMATION PROVIDED BY OTHERS.
- PROVIDE SEISMIC BRACING OF ALL EQUIPMENT AND PIPING AS REQUIRED BY LOCAL CODES.
- COORDINATE AVAILABLE SPACE FOR EQUIPMENT AND PIPING SYSTEMS WITH OTHER TRADES. REFER TO ARCHITECTURAL, STRUCTURAL, PLUMBING, AND ELECTRICAL DRAWINGS AND FIRE PROTECTION SHOP DRAWINGS FOR ADDITIONAL DETAILS NECESSARY FOR COORDINATION.
- ALL PIPING IS SCHEMATICALLY DRAWN AND COORDINATION BETWEEN TRADES MUST BE DONE FOR PROPER EQUIPMENT, PIPING, AND DUCTWORK PLACEMENT AND DESIGN.
- CONTRACTOR IS TO ROUTE ALL PIPING TO AVOID STRUCTURAL MEMBERS AS FIELD CONDITIONS DICTATE. IF PIPING IS SHOWN AS GOING THROUGH A STRUCTURAL MEMBER, THIS WILL NEED TO BE ADJUSTED IN THE FIELD TO FIT OR THE MEMBER WILL NEED TO BE PENETRATED. PIPING LOCATIONS ARE SHOWN AS APPROXIMATE AND NOT EXACT. CONTRACTOR IS TO CHECK PIPING DIMENSIONS IN THE FIELD.
- FOLLOW MANUFACTURES WRITTEN INSTALLATION INSTRUCTION FOR RUNNING THE COMBUSTION AIR AND VENT PIPING AS WELL AS THE TERMINATION THROUGH THE ROOF, FOLLOW ALL SAFETY INSTRUCTIONS.
- COORDINATE ALL CONCRETE PENETRATIONS WITH STRUCTURAL DRAWINGS TO VERIFY HOW AND WHERE CONCRETE CAN BE CUT.
- ALL PIPING THAT IS EXPOSED MUST BE PAINTED TO MATCH SURROUNDINGS.
- MECHANICAL CONTRACTOR SHALL FIRE SEAL ALL PIPING PASSING THROUGH RATED CONSTRUCTION.

KEY NOTES:

- 1. NO PLUMBING MODIFICATIONS ANTICIPATED FOR PHASE 2
- 2. THE CONTRACTOR SHALL MODIFIY THE SPRINKLER LAYOUT TO ACCOMMODATE ARCHITECTURAL CHANGES AND ORDINARY HAZARD GROUP 1 CLASSIFICATION BECAUSE OF THE CHANGE FROM OFFICE SPACE TO STORAGE SPACE

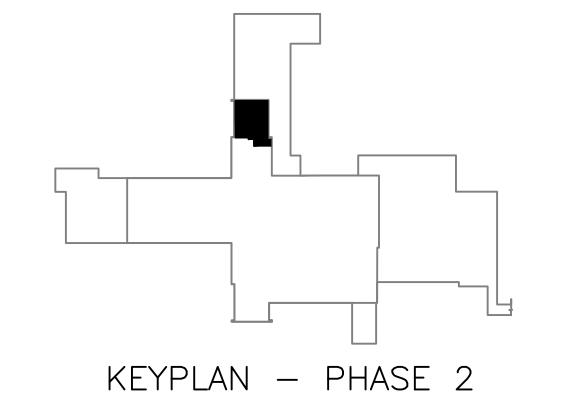

Construction Document Submission

18 July 2014 Project Number Office of

Drawing Title
PLUMBING PLAN - PHASE 2 Project Title VAMC FORT HARRISON Building Number SPD RENOVATION Approved: Project Director Drawing Number Location FT. HARRISON, MONTANA AARON DRIVDAHL, PROJECT ENGINEER PL102 VAMC FORT HARRISON

Management

Construction

and Facilities


ARCHITECT/ENGINEERS:

www.aearchitects.com

Program, Project and Construction Management

Checked TCH JTW

Department of Veterans Affairs Dwg. 29 of 39

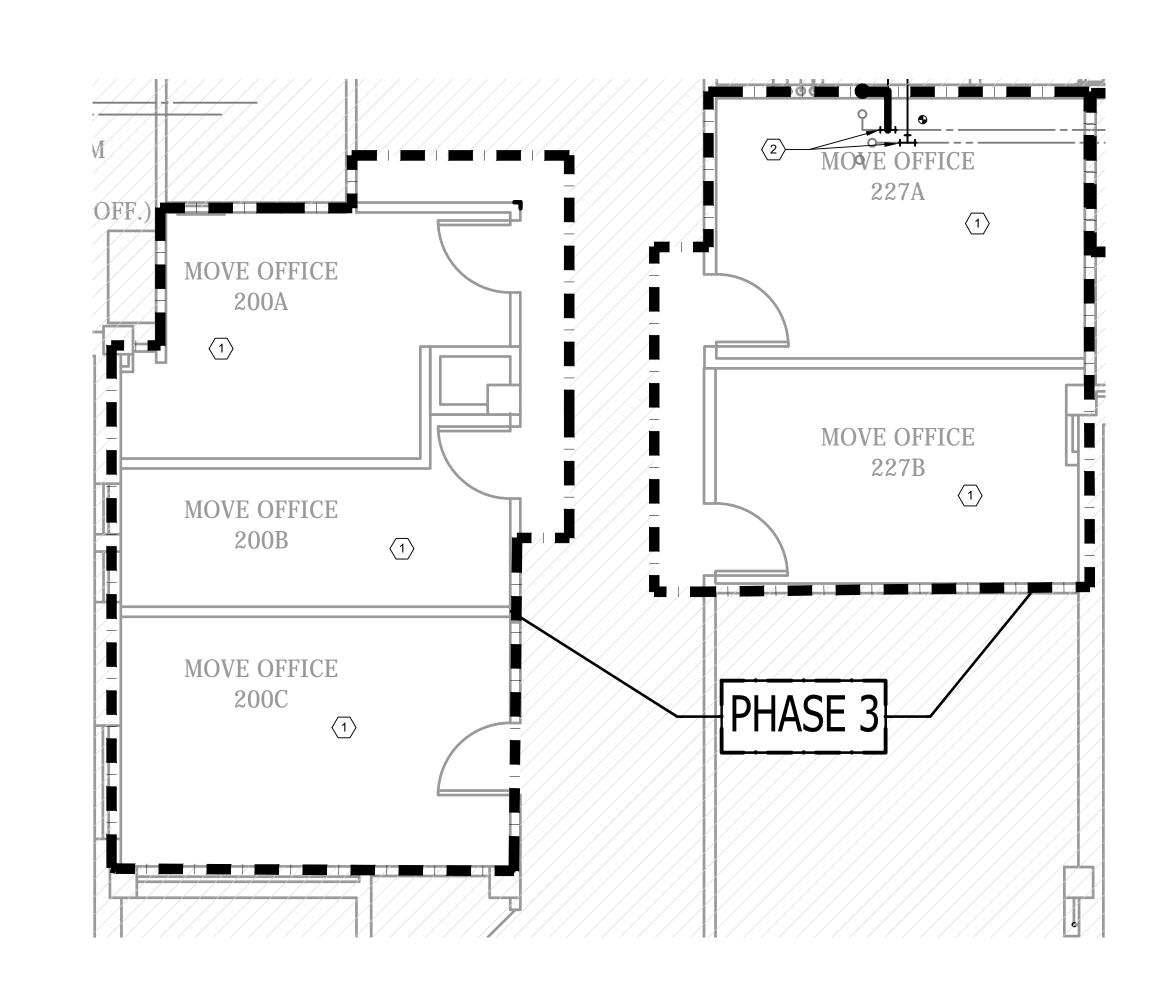


\PLUMBING LAYOUT PL103/1/4" = 1'-0"

GENERAL NOTES:

- IT IS ABSOLUTELY NECESSARY FOR ALL TRADES INVOLVED TO COORDINATE WITH EACH OTHER AND VERIFY THAT THERE ARE NO CONFLICTS IN LOCATION OF PIPING DUCTS, CONDUITS, DIFFUSERS, BOXES AND OTHER ITEMS THROUGHOUT THIS PROJECT BEFORE FINAL PLACEMENT OF MATERIALS.
- ALL DIMENSIONS AND EXACT UNIT AND PIPING LOCATIONS ARE TO BE FIELD VERIFIED. THESE DRAWINGS REPRESENT SCHEMATIC SYSTEMS BASED ON INFORMATION PROVIDED BY OTHERS.
- PROVIDE SEISMIC BRACING OF ALL EQUIPMENT AND PIPING AS REQUIRED BY LOCAL CODES.
- COORDINATE AVAILABLE SPACE FOR EQUIPMENT AND PIPING SYSTEMS WITH OTHER TRADES. REFER TO ARCHITECTURAL, STRUCTURAL, PLUMBING, AND ELECTRICAL DRAWINGS AND FIRE PROTECTION SHOP DRAWINGS FOR ADDITIONAL DETAILS NECESSARY FOR COORDINATION.
- ALL PIPING IS SCHEMATICALLY DRAWN AND COORDINATION BETWEEN TRADES MUST BE DONE FOR PROPER EQUIPMENT, PIPING, AND DUCTWORK PLACEMENT AND DESIGN.
- CONTRACTOR IS TO ROUTE ALL PIPING TO AVOID STRUCTURAL MEMBERS AS FIELD CONDITIONS DICTATE. IF PIPING IS SHOWN AS GOING THROUGH A STRUCTURAL MEMBER, THIS WILL NEED TO BE ADJUSTED IN THE FIELD TO FIT OR THE MEMBER WILL NEED TO BE PENETRATED. PIPING LOCATIONS ARE SHOWN AS APPROXIMATE AND NOT EXACT. CONTRACTOR IS TO CHECK PIPING DIMENSIONS IN THE FIELD.
- FOLLOW MANUFACTURES WRITTEN INSTALLATION INSTRUCTION FOR RUNNING THE COMBUSTION AIR AND VENT PIPING AS WELL AS THE TERMINATION THROUGH THE ROOF. FOLLOW ALL SAFETY INSTRUCTIONS.
- COORDINATE ALL CONCRETE PENETRATIONS WITH STRUCTURAL DRAWINGS TO VERIFY HOW AND WHERE CONCRETE CAN BE CUT.
- ALL PIPING THAT IS EXPOSED MUST BE PAINTED TO MATCH SURROUNDINGS.
- MECHANICAL CONTRACTOR SHALL FIRE SEAL ALL PIPING PASSING THROUGH RATED CONSTRUCTION.

- 1. MODIFY SPRINKLER LAYOUT TO ACCOMMODATE ARCHITECTURAL CHANGES IN THIS AREA
- 2. WORK REQUIRED IN PHASE 4 SEE DRAWING PL104 FOR DETAILS

KEY NOTES:

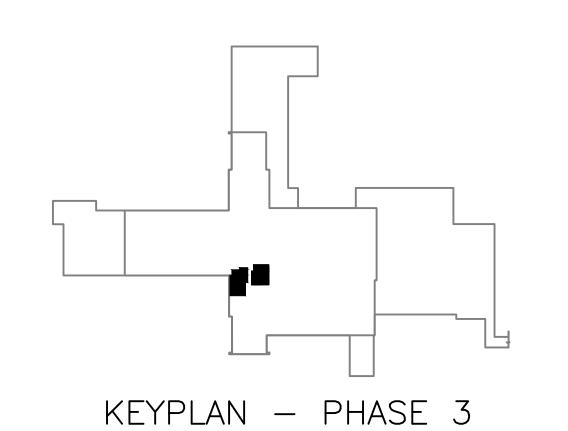

Construction Document Submission 18 July 2014

CONSULTANTS: MORRISON
Surveyors
Scientists
NAIERLE, INC.
Planners | -| --An Employee-Owned Company 125 Schoolhouse Loop Kalispell, MT 59901 406.752.2216

VA FORM 08-6231

INTERIORS HISTORIC

608 NORTH 29TH BILLINGS, MT 59101 PH 406.248.2633 224 N. HIGGINS, SUITE B MISSOULA, M T 59802 PH 4 0 6 . 7 2 1 . 5 6 4 3 FAX 406.721.1887 www.aearchitects.com



Program, Project and Construction Management

Drawing Title
PLUMBING PLAN - PHASE 3 Approved: Project Director AARON DRIVDAHL, PROJECT ENGINEER VAMC FORT HARRISON

VAMC FORT HARRISON SPD RENOVATION Location FT. HARRISON, MONTANA Checked

JTW


TCH


Project Title

Project Number Office of Construction Building Number and Facilities Drawing Number Management PL103

Dwg. 30 of 39

Department of Veterans Affairs

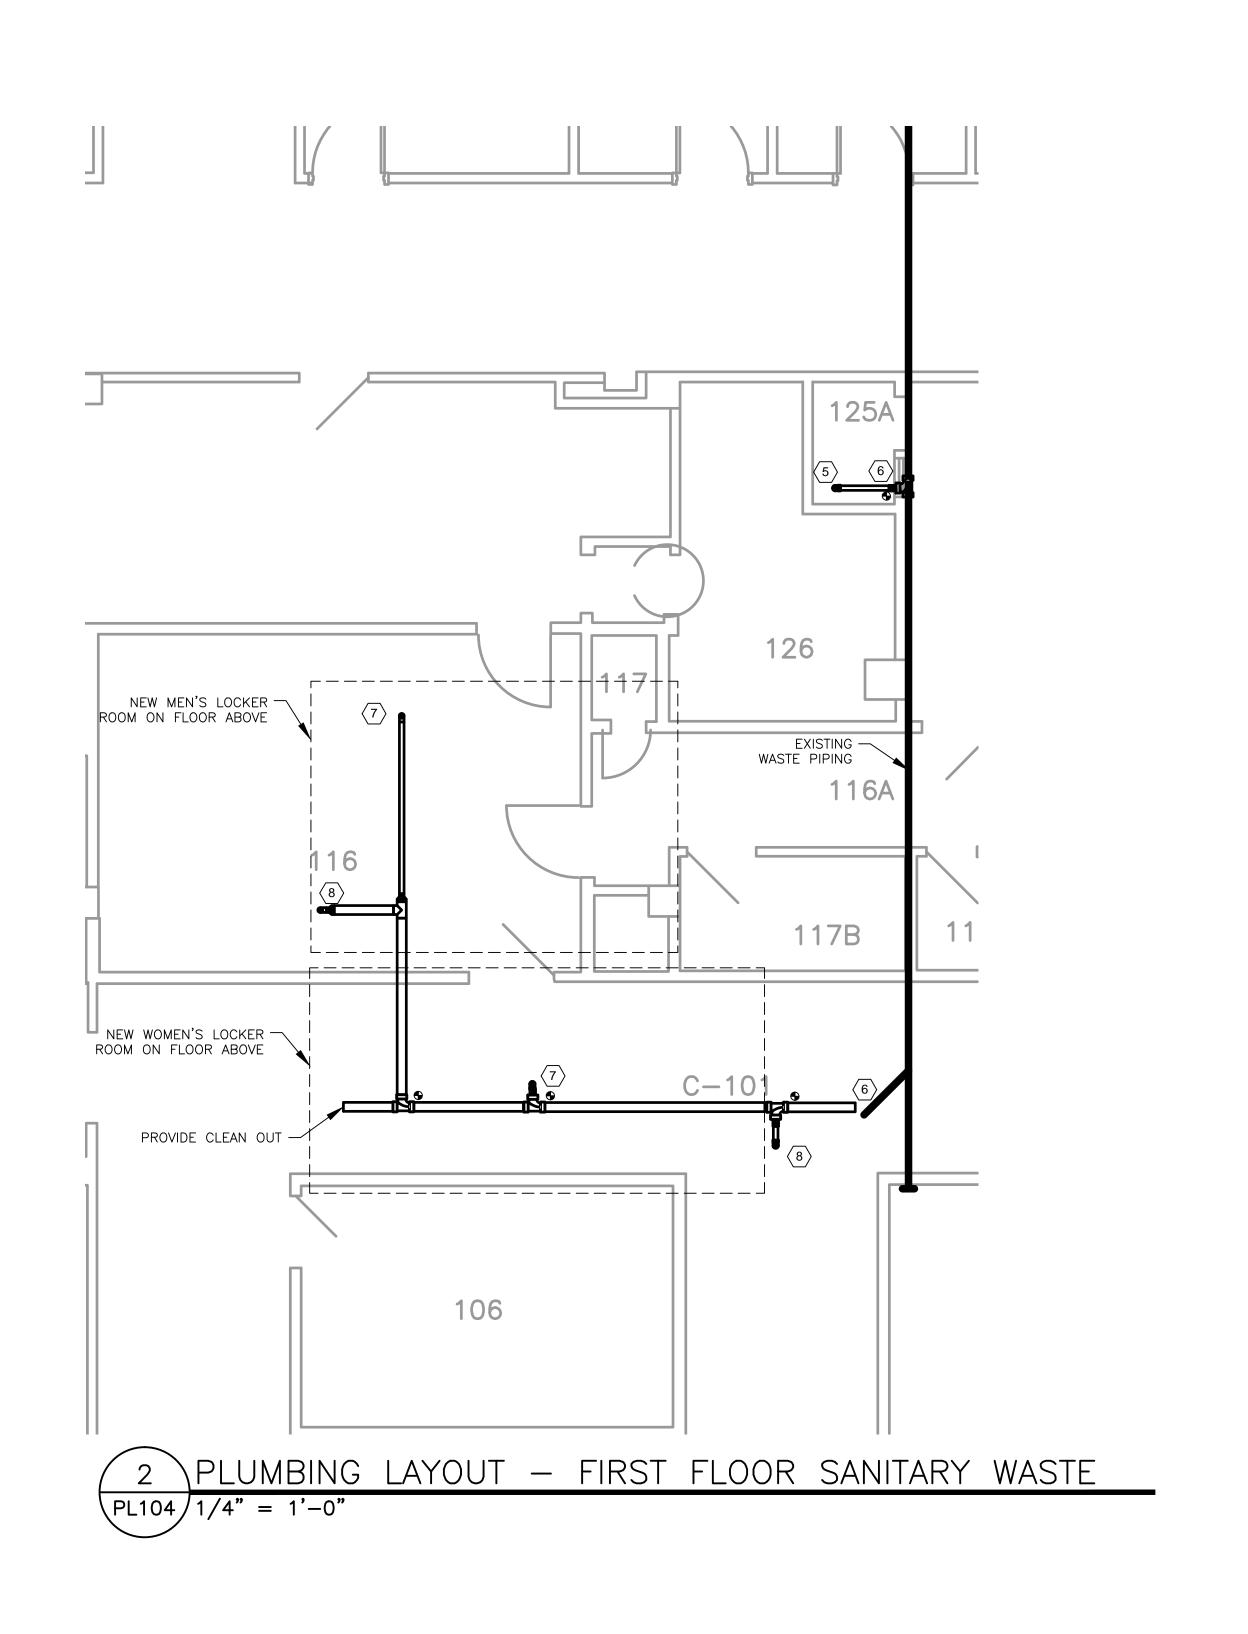

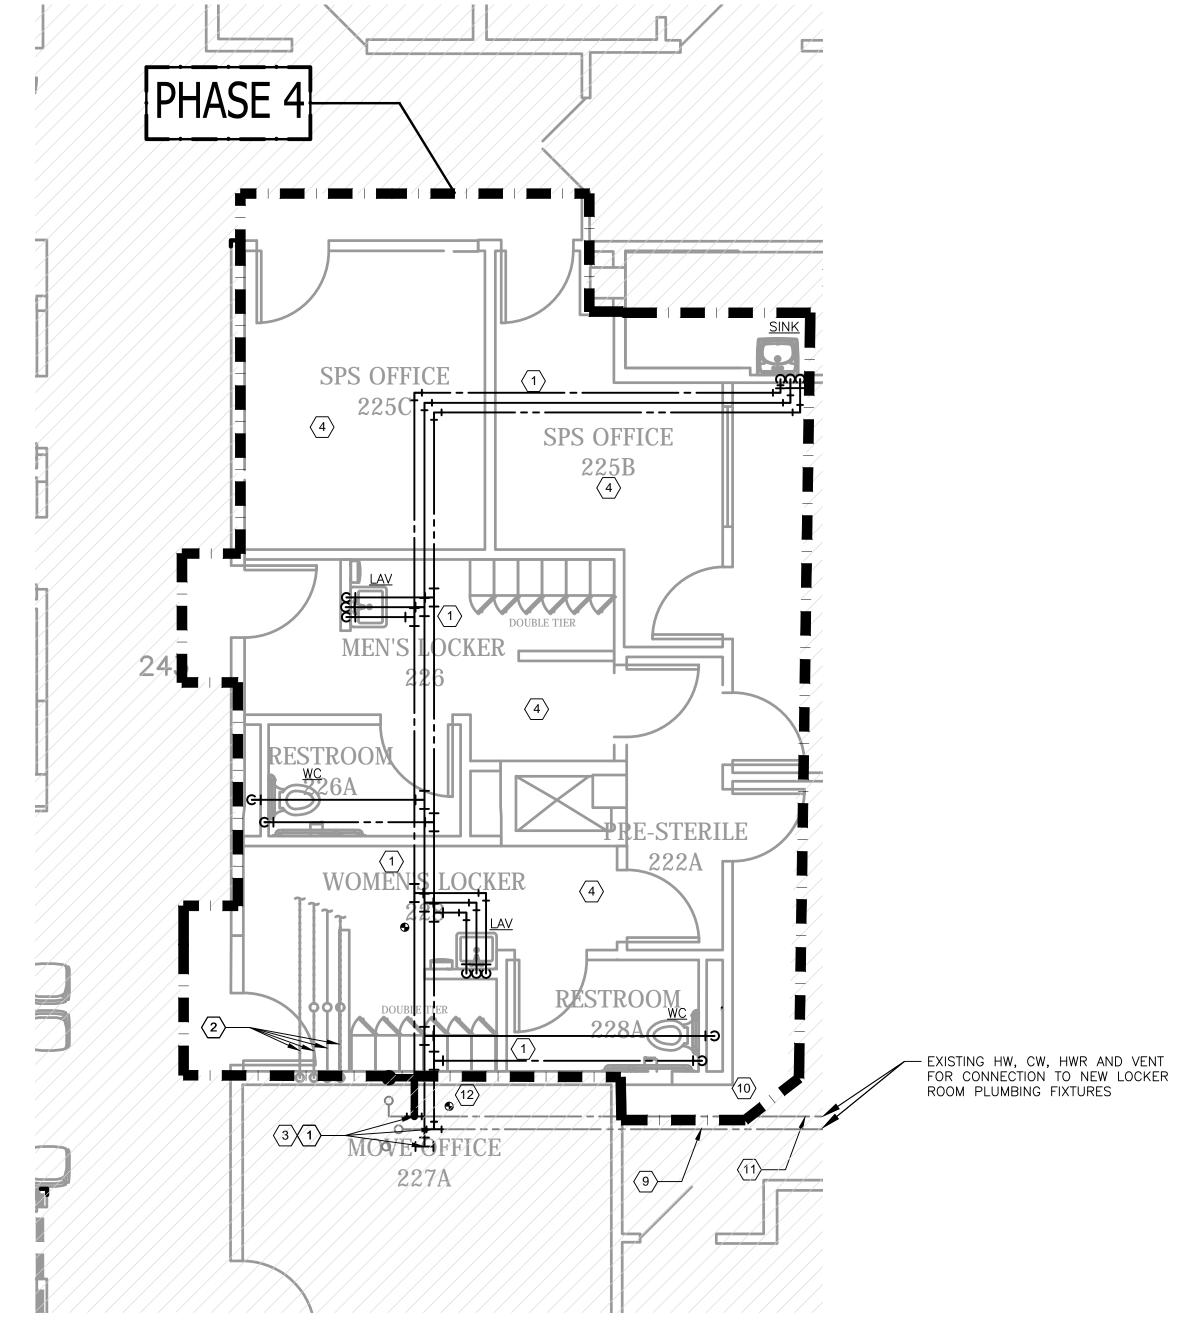

1 PLUMBING LAYOUT - SECOND FLOOR WATER AND VENT

GENERAL NOTES:

- A. IT IS ABSOLUTELY NECESSARY FOR ALL TRADES INVOLVED TO COORDINATE WITH EACH OTHER AND VERIFY THAT THERE ARE NO CONFLICTS IN LOCATION OF PIPING DUCTS, CONDUITS, DIFFUSERS, BOXES AND OTHER ITEMS THROUGHOUT THIS PROJECT BEFORE FINAL PLACEMENT OF MATERIALS.
- B. ALL DIMENSIONS AND EXACT UNIT AND PIPING LOCATIONS ARE TO BE FIELD VERIFIED. THESE DRAWINGS REPRESENT SCHEMATIC SYSTEMS BASED ON INFORMATION PROVIDED BY OTHERS.
- PROVIDE SEISMIC BRACING OF ALL EQUIPMENT AND PIPING AS REQUIRED BY LOCAL CODES.
- D. COORDINATE AVAILABLE SPACE FOR EQUIPMENT AND PIPING SYSTEMS WITH OTHER TRADES. REFER TO ARCHITECTURAL, STRUCTURAL, PLUMBING, AND ELECTRICAL DRAWINGS AND FIRE PROTECTION SHOP DRAWINGS FOR ADDITIONAL DETAILS NECESSARY FOR COORDINATION.
- E. ALL PIPING IS SCHEMATICALLY DRAWN AND COORDINATION BETWEEN TRADES MUST BE DONE FOR PROPER EQUIPMENT, PIPING, AND DUCTWORK PLACEMENT AND DESIGN.
- CONTRACTOR IS TO ROUTE ALL PIPING TO AVOID STRUCTURAL MEMBERS AS FIELD CONDITIONS DICTATE. IF PIPING IS SHOWN AS GOING THROUGH A STRUCTURAL MEMBER, THIS WILL NEED TO BE ADJUSTED IN THE FIELD TO FIT OR THE MEMBER WILL NEED TO BE PENETRATED. PIPING LOCATIONS ARE SHOWN AS APPROXIMATE AND NOT EXACT. CONTRACTOR IS TO CHECK PIPING DIMENSIONS IN THE FIELD.
- G. FOLLOW MANUFACTURES WRITTEN INSTALLATION INSTRUCTION FOR RUNNING THE COMBUSTION AIR AND VENT PIPING AS WELL AS THE TERMINATION THROUGH THE ROOF. FOLLOW ALL SAFETY INSTRUCTIONS.
- H. COORDINATE ALL CONCRETE PENETRATIONS WITH STRUCTURAL DRAWINGS TO VERIFY HOW AND WHERE CONCRETE CAN BE CUT.
- ALL PIPING THAT IS EXPOSED MUST BE PAINTED TO MATCH SURROUNDINGS.
- J. MECHANICAL CONTRACTOR SHALL FIRE SEAL ALL PIPING PASSING THROUGH RATED CONSTRUCTION.

KEY NOTES:

- 1. RUN NEW HOT WATER, COLD WATER AND VENT PIPING TO ALL NEW LOCKER ROOM FIXTURES IN THIS AREA FROM CEILING SPACE OF ADJACENT OFFICE 227.
- 2. REMOVE MED-GAS PANEL AND REMOVE
 EXISTING PIPING BACK TO MED GAS MAINS —
 THIS CONSISTS OF NITROUS OXIDE PIPING,
 COMPRESSED AIR PIPING, VACUUM PIPING, AND
 OXYGEN PIPING.
- SEE DRAWING PL103 FOR CONTINUATION
 MODIFY SPRINKLER LAYOUT TO ACCOMMODATE ARCHITECTURAL CHANGES IN THESE AREAS.
 2" SANITARY WASTE FROM SINK ABOVE.
- 6. TIE INTO EXISTING WASTE PIPING AT THIS POINT CONTRACTOR TO VERIFY PIPING PRIOR TO BEGINNING ANY PIPING.
- PRIOR TO BEGINNING ANY PIPING.

 7. 2" SANITARY WASTE PIPING FROM NEW LAVATORY ABOVE.
- 8. 3" SANITARY WASTE PIPING FROM NEW WATER CLOSET ABOVE.
- 9. EXISTING VENT PIPING TO REMAIN CONTRACTOR VERIFY LOCATION.
- 10. EXISTING COLD WATER SUPPLY PIPING TO
- REMAIN CONTRACTOR VERIFY LOCATION.


 11. EXISTING HOT WATER SUPPLY PIPING TO

 REMAIN CONTRACTOR VERIFY LOCATION
- REMAIN CONTRACTOR VERIFY LOCATION. 12. THIS WALL IS A FIRE WALL — ALL PENETRATIONS THROUGH THIS WALL MUST BE DONE TO MAINTAIN THE FIRE RATING OF THE

WALL.

TCH

JTW

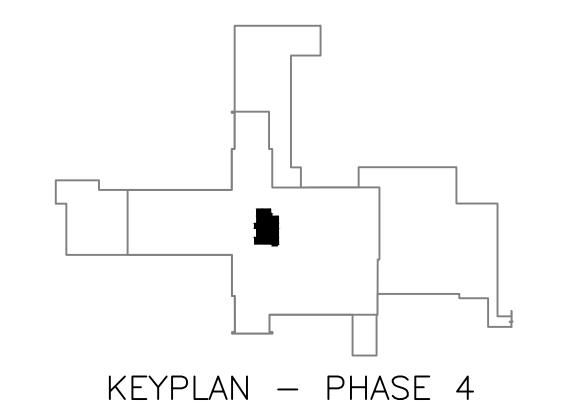

Construction Document Submission 18 July 2014


VA FORM 08-623

ARCHITECTS&
ARCHITECTURE
INTERIORS
HISTORIC

608 NORTH 29TH
BILLINGS, MT 59101
PH 406.248.2633
FAX 406.248.2427

224 N. HIGGINS, SUITE B
MISSOULA, MT 59802
PH 406.721.5643
FAX 406.721.1887

www.aearchitects.com

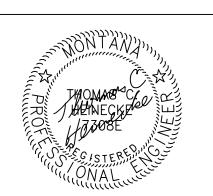



Drawing Title
PLUMBING PLAN - PHASE 4

Approved: Project Director

AARON DRIVDAHL, PROJECT ENGINEER
VAMC FORT HARRISON

PHASE 4

VAMC FORT HARRISON
SPD RENOVATION

Location
FT. HARRISON, MONTANA

PROJECT ENGINEER

Project Number
436-14-109

Building Number
154


Drawing Number


PL104

Office of
Construction
and Facilities
Management


Dwg. 31 of 39

Department of Veterans Affairs

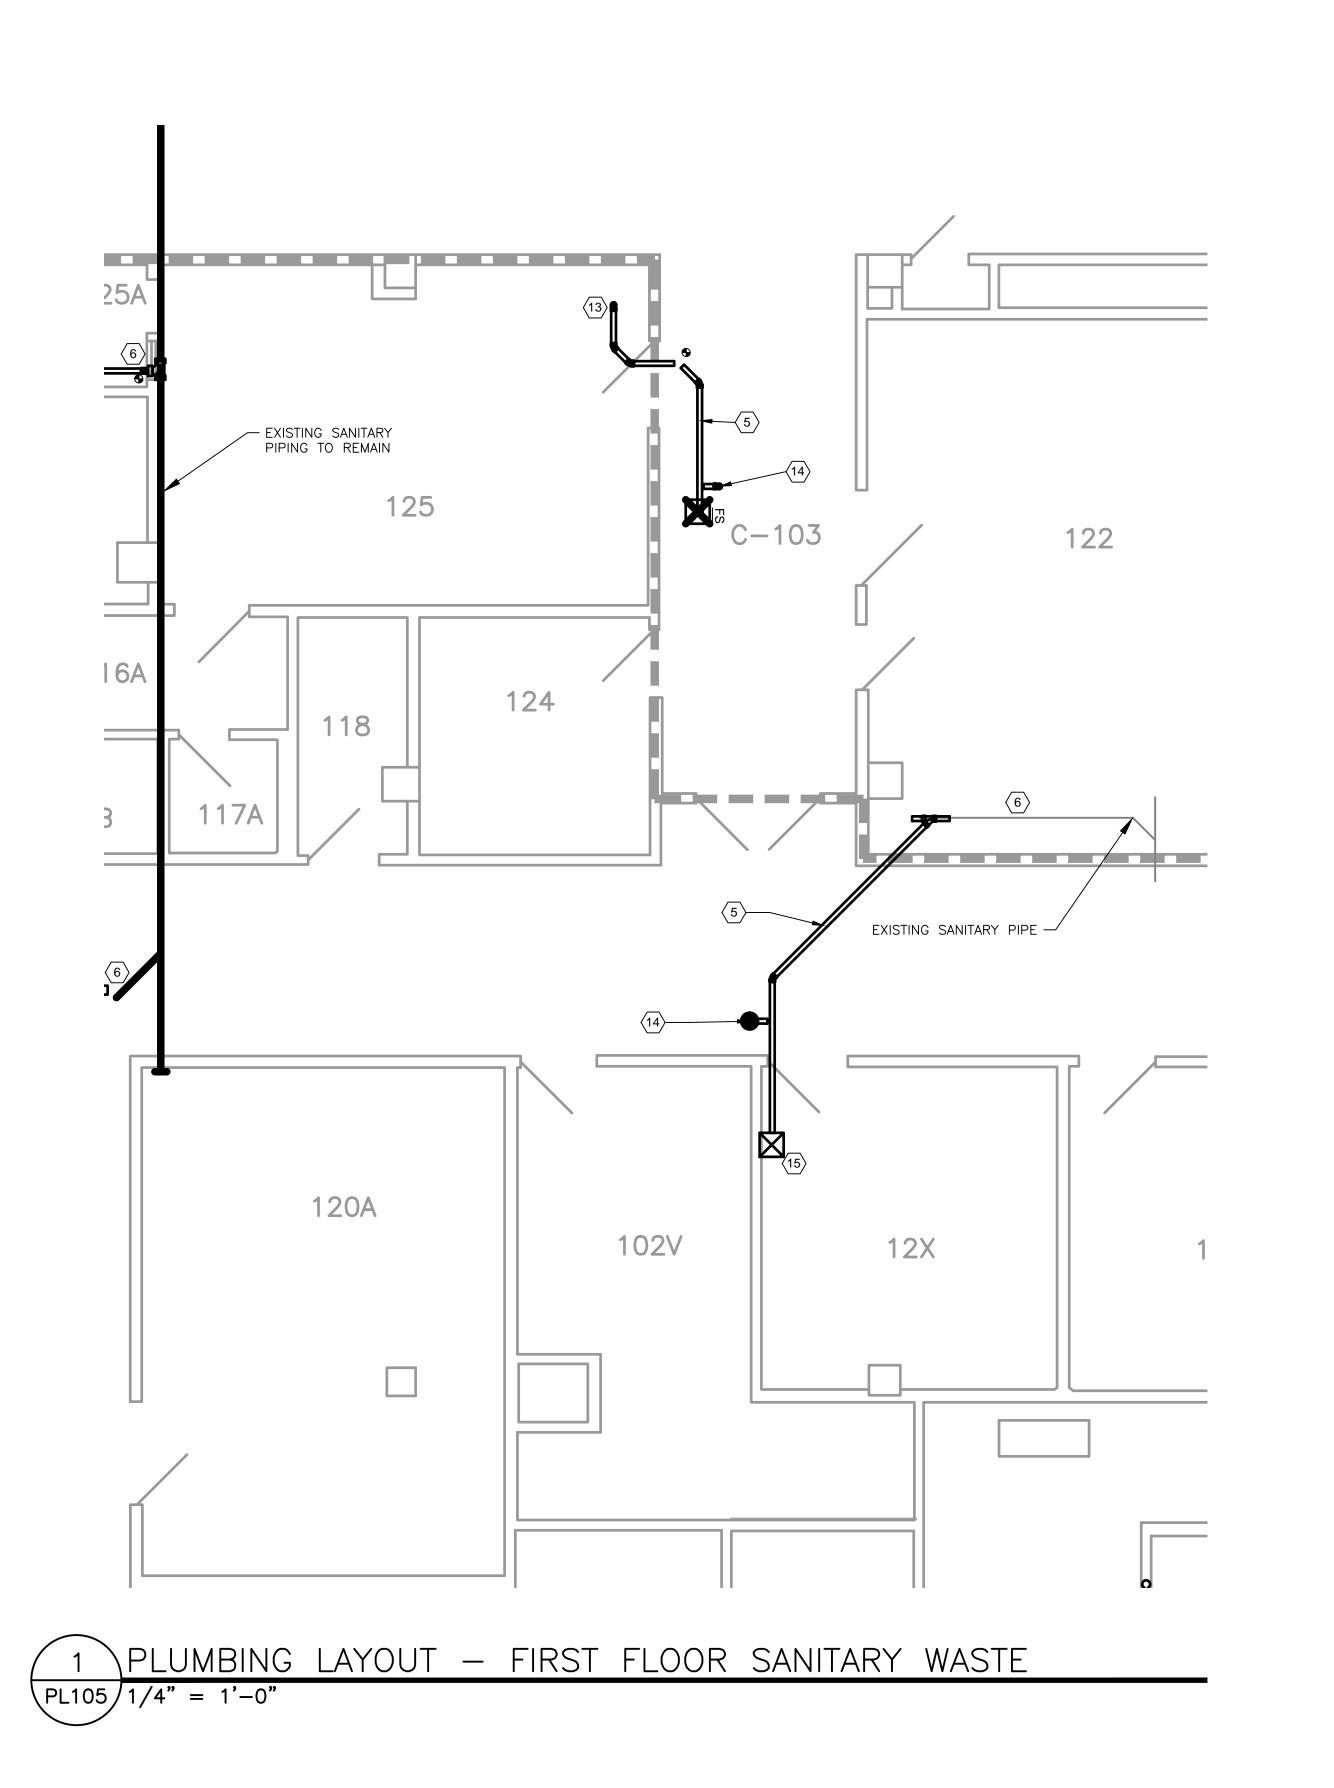

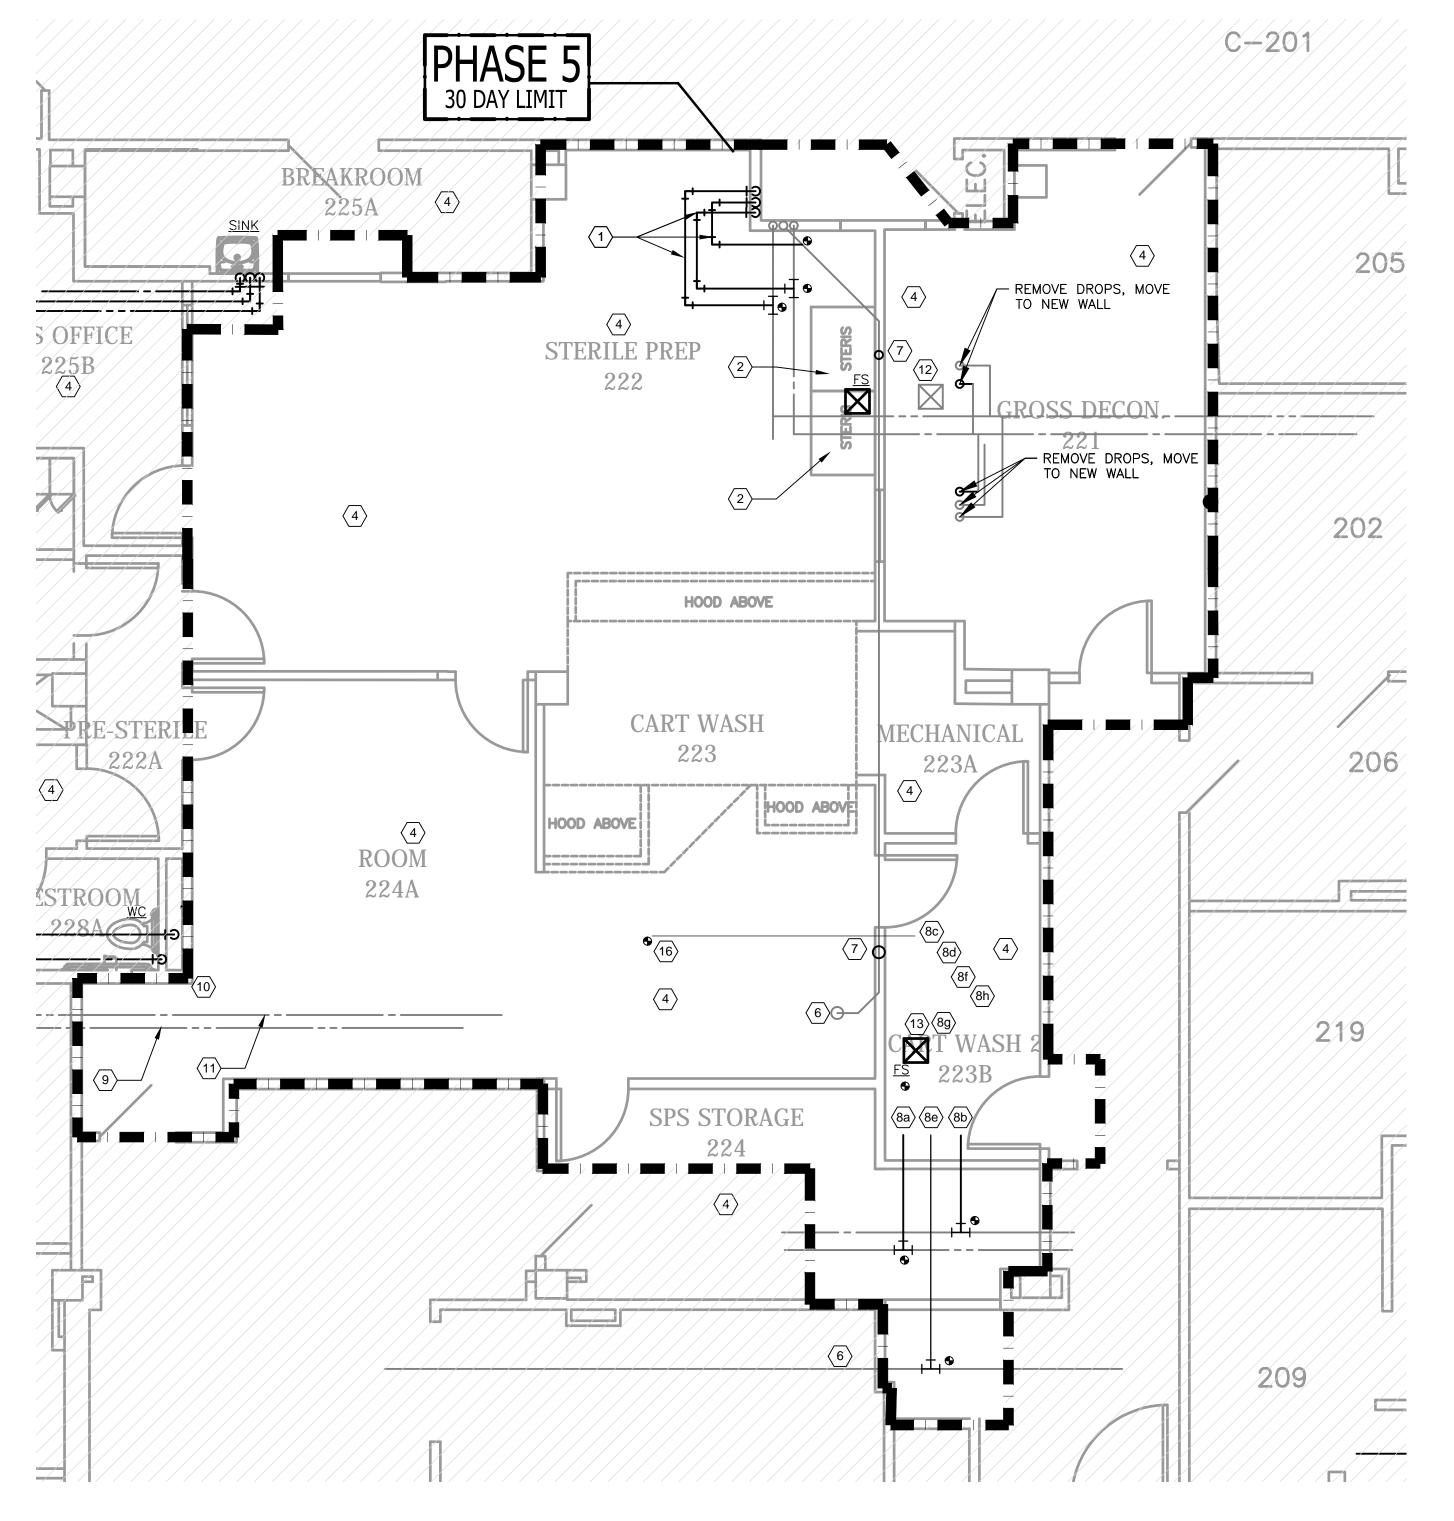

2 PLUMBING LAYOUT — SECOND FLOOR MGAS, WATER AND VENT PL105/1/4" = 1'-0"

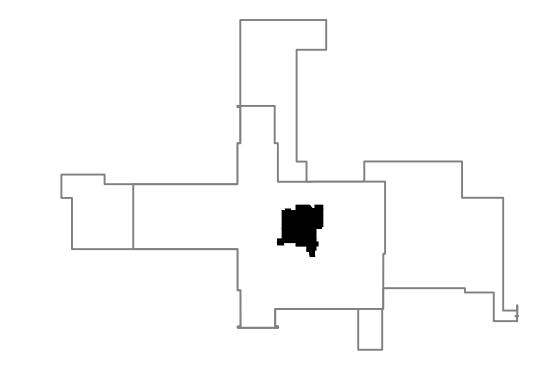

KEYPLAN - PHASE 5

Construction Document Submission 18 July 2014

ARCHITECT/ENGINEERS: Program, Project and Construction Management

Drawing Title
PLUMBING PLAN - PHASE 5 Project Title VAMC FORT HARRISON SPD RENOVATION Approved: Project Director FT. HARRISON, MONTANA AARON DRIVDAHL, PROJECT ENGINEER

Building Number Drawing Number

Office of Construction and Facilities Management

Department of Veterans Affairs

CONSULTANTS: MORRISON 125 Schoolhouse Loop Kalispell, MT 59901 406.752.2216

608 NORTH 29TH BILLINGS, MT 59101 224 N. HIGGINS, SUITE B MISSOULA, M T 59802 PH 4 0 6 . 7 2 1 . 5 6 4 3 FAX 406.721.1887 INTERIORS HISTORIC www.aearchitects.com



Checked TCH JTW

PL105 Dwg. 32 of 39

GENERAL NOTES:

LOCATION OF PIPING DUCTS, CONDUITS, DIFFUSERS,

PROJECT BEFORE FINAL PLACEMENT OF MATERIALS.

DRAWINGS REPRESENT SCHEMATIC SYSTEMS BASED

PROVIDE SEISMIC BRACING OF ALL EQUIPMENT AND

COORDINATE AVAILABLE SPACE FOR EQUIPMENT AND PIPING SYSTEMS WITH OTHER TRADES. REFER TO ARCHITECTURAL, STRUCTURAL, PLUMBING, AND

ELECTRICAL DRAWINGS AND FIRE PROTECTION SHOP

DRAWINGS FOR ADDITIONAL DETAILS NECESSARY

COORDINATION BETWEEN TRADES MUST BE DONE

FOR PROPER EQUIPMENT, PIPING, AND DUCTWORK

CONTRACTOR IS TO ROUTE ALL PIPING TO AVOID

A STRUCTURAL MEMBER, THIS WILL NEED TO BE ADJUSTED IN THE FIELD TO FIT OR THE MEMBER

FOLLOW MANUFACTURES WRITTEN INSTALLATION INSTRUCTION FOR RUNNING THE COMBUSTION AIR AND VENT PIPING AS WELL AS THE TERMINATION

COORDINATE ALL CONCRETE PENETRATIONS WITH STRUCTURAL DRAWINGS TO VERIFY HOW AND

ALL PIPING THAT IS EXPOSED MUST BE PAINTED

MECHANICAL CONTRACTOR SHALL FIRE SEAL ALL

PIPING PASSING THROUGH RATED CONSTRUCTION.

KEY NOTES:

1. RELOCATE SINK AND RECONFIGURE COLD WATER

2. WATER AND AIR CONNECTIONS TO NEW

4. MODIFY FIRE SPRINKLER LAYOUT TO

3. SEE DRAWING PL104 FOR CONTINUATION

ACCOMMODATE ARCHITECTURAL CHANGES.

7. NEW 2" VENT FROM BELOW — CONNECT TO

8. CONNECT NEW CART WASHER TO EXISTING

6. EXISTING PIPING TO REMAIN - CONTRACTOR TO

UTILITIES — CONTRACTOR SHALL VERIFY ALL SERVICES PRIOR TO STARTING ANY PIPING WORK - WORK OUT ANY ISSUES WITH THE ENGINEER

8.d. CONDENSATE RETURN — 1" (DETERMINE

8.h. PURE WATER - 1" (DETERMINE ROUTING IN

10. EXISTING COLD WATER PIPING TO REMAIN -

12. NEW 2" SANITARY WASTE FROM RELOCATED SINK

16. CONNECT NEW LOW PRESSURE STEAM PIPING TO

11. EXISTING HOT WATER PIPING TO REMAIN -

13. NEW FLOOR SINK - LOCATE AS PER CART EQUIPMENT MANUFACTURER'S WRITTEN

EXISTING 2" STEAM PIPING IN THIS AREA.

8.f. VENTILATION DUCT - 6" (DETERMINE

8.g. INDIRECT DRAIN (TO FLOOR SINK)

9. EXISTING VENT PIPING TO REMAIN -CONTRACTOR TO VERIFY LOCATION.

CONTRACTOR TO VERIFY LOCATION.

CONTRACTOR TO VERIFY LOCATION.

15. 4" WASTE FROM FLOOR SINK ABOVE.

INSTALLATION INSTRUCTIONS.

HOT WATER, AND VENT TO NEW SINK LOCATION.

THROUGH THE ROOF. FOLLOW ALL SAFETY

WHERE CONCRETE CAN BE CUT.

TO MATCH SURROUNDINGS.

EQUIPMENT LOCATIONS.

5. NEW 4" SANITARY WASTE.

EXISTING VENT PIPING.

PRIOR TO STARTING: 8.a. HOT WATER - 1" 8.b. COLD WATER - 1" 8.c. STEAM - 1-1/2"

ROUTING IN FIELD) 8.e. COMPRESSED AIR -1/2"

ROUTING IN FIELD)

FIELD)

14. NEW 2" VENT UP.

VERIFY LOCATION.

DICTATE. IF PIPING IS SHOWN AS GOING THROUGH

WILL NEED TO BE PENETRATED. PIPING LOCATIONS ARE SHOWN AS APPROXIMATE AND NOT EXACT. CONTRACTOR IS TO CHECK PIPING DIMENSIONS IN

STRUCTURAL MEMBERS AS FIELD CONDITIONS

ALL PIPING IS SCHEMATICALLY DRAWN AND

IT IS ABSOLUTELY NECESSARY FOR ALL TRADES INVOLVED TO COORDINATE WITH EACH OTHER AND

VERIFY THAT THERE ARE NO CONFLICTS IN

BOXES AND OTHER ITEMS THROUGHOUT THIS

ALL DIMENSIONS AND EXACT UNIT AND PIPING LOCATIONS ARE TO BE FIELD VERIFIED. THESE

ON INFORMATION PROVIDED BY OTHERS.

PIPING AS REQUIRED BY LOCAL CODES.

FOR COORDINATION.

THE FIELD.

INSTRUCTIONS.

PLACEMENT AND DESIGN.

VA FORM 08-623

VAMC FORT HARRISON

Project Number